




FRONT ELEVATION

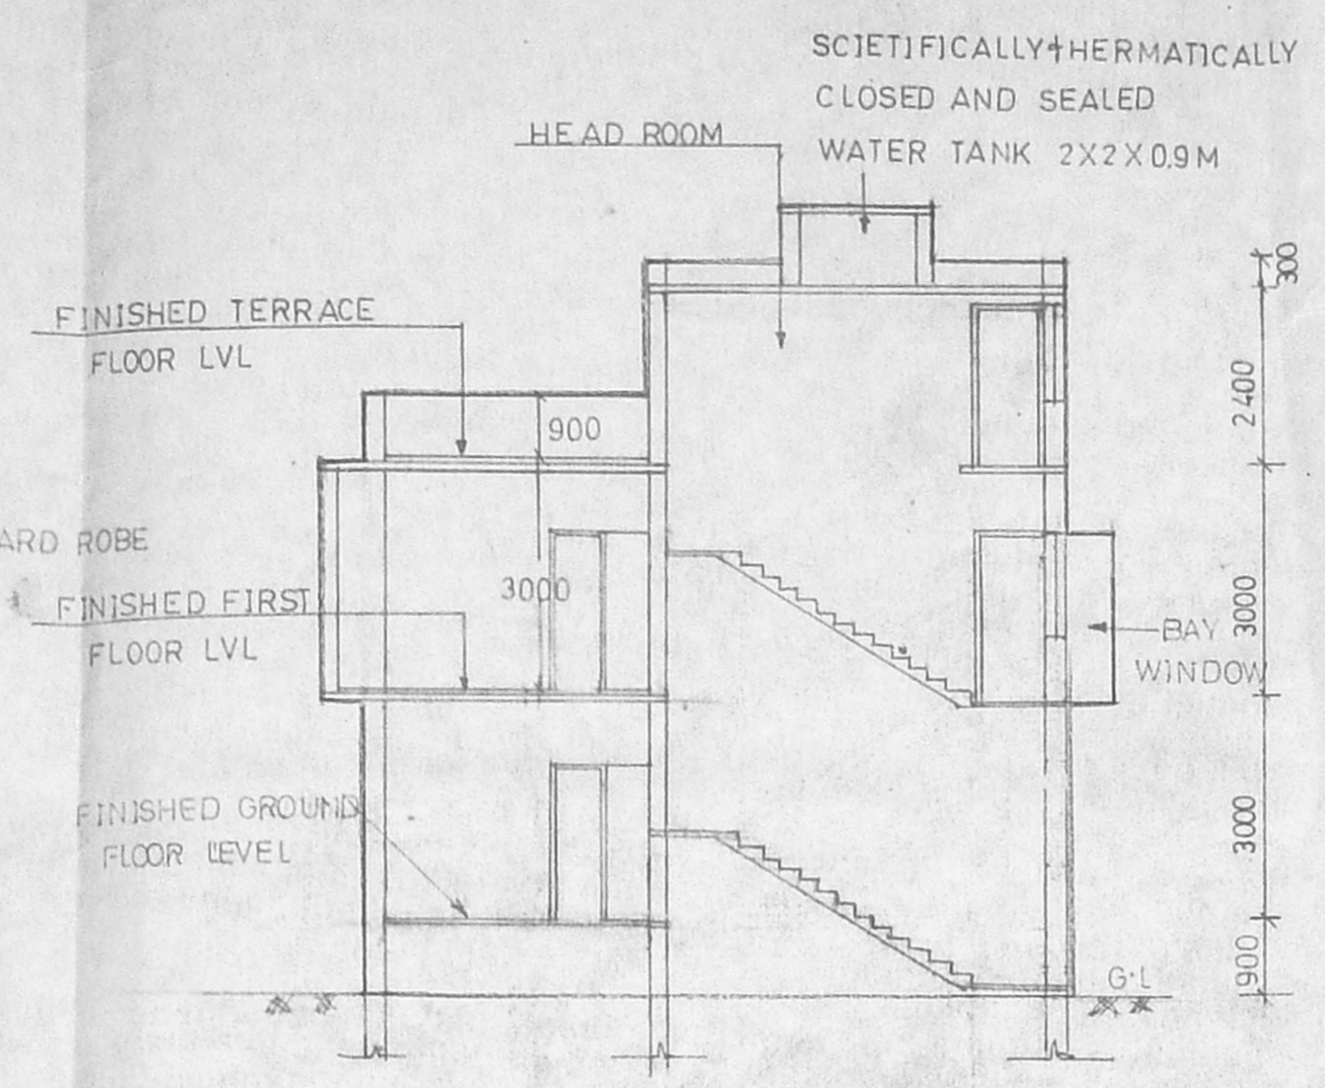


SECTION ON AB

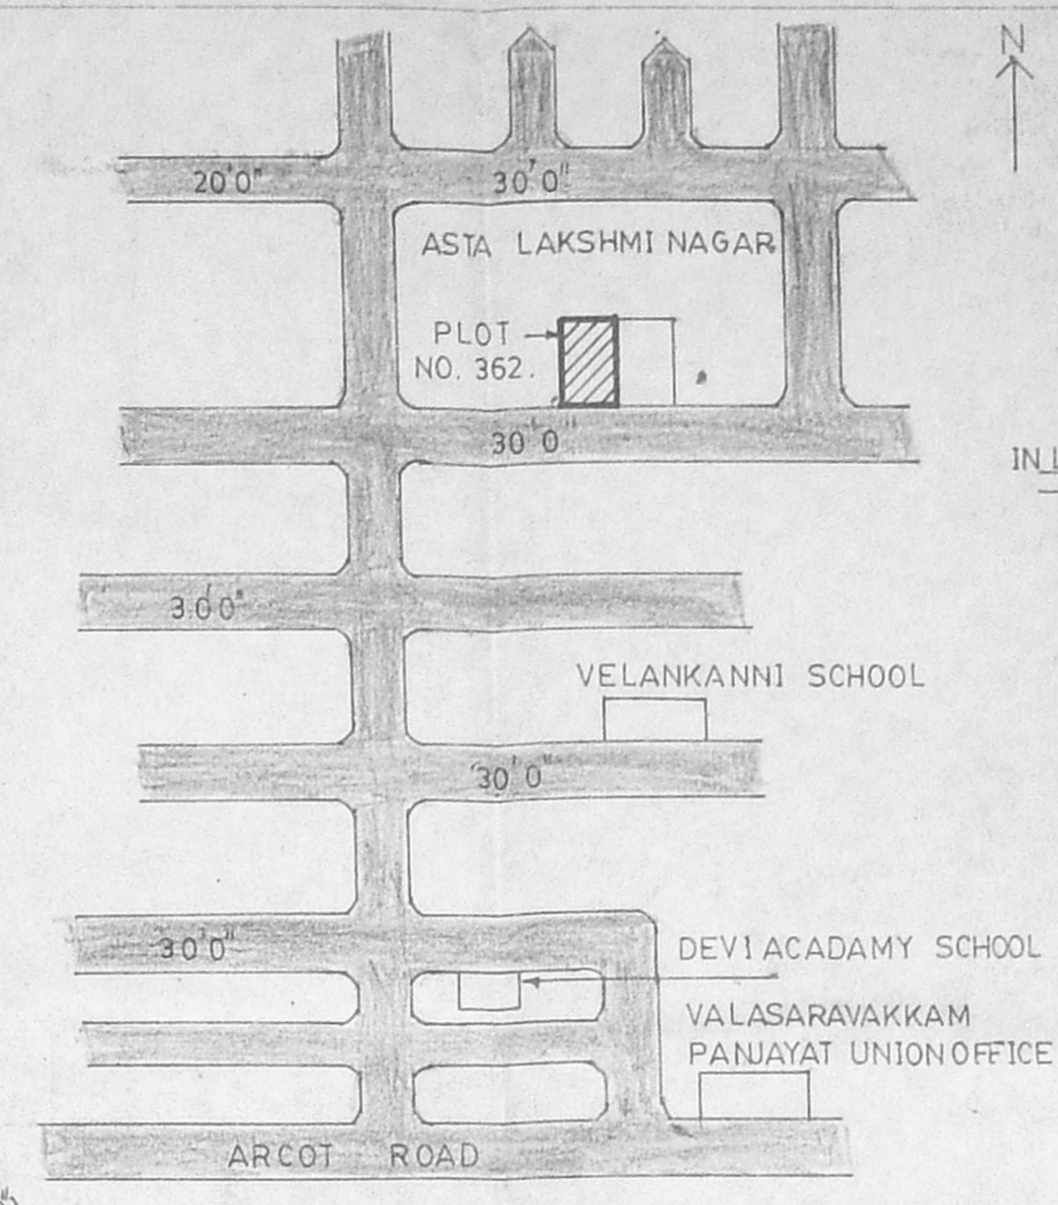


TOPO PLAN (NOT TO SCALE)

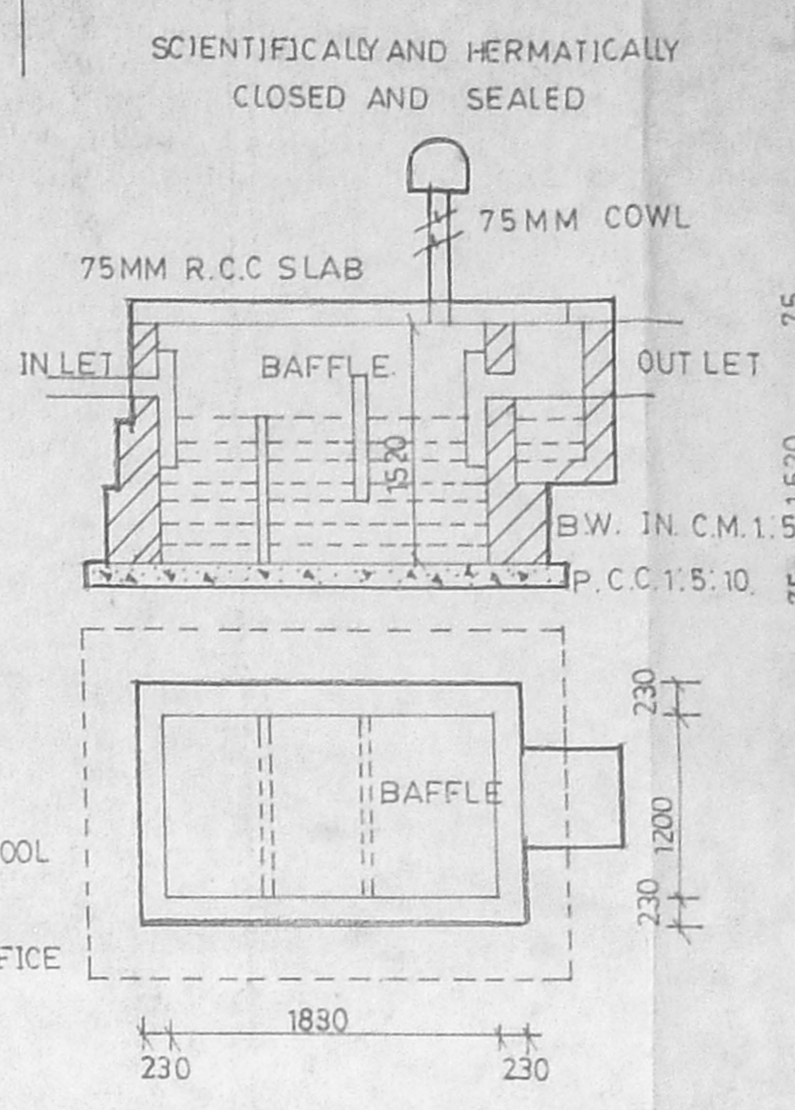

SEPTIC TANK

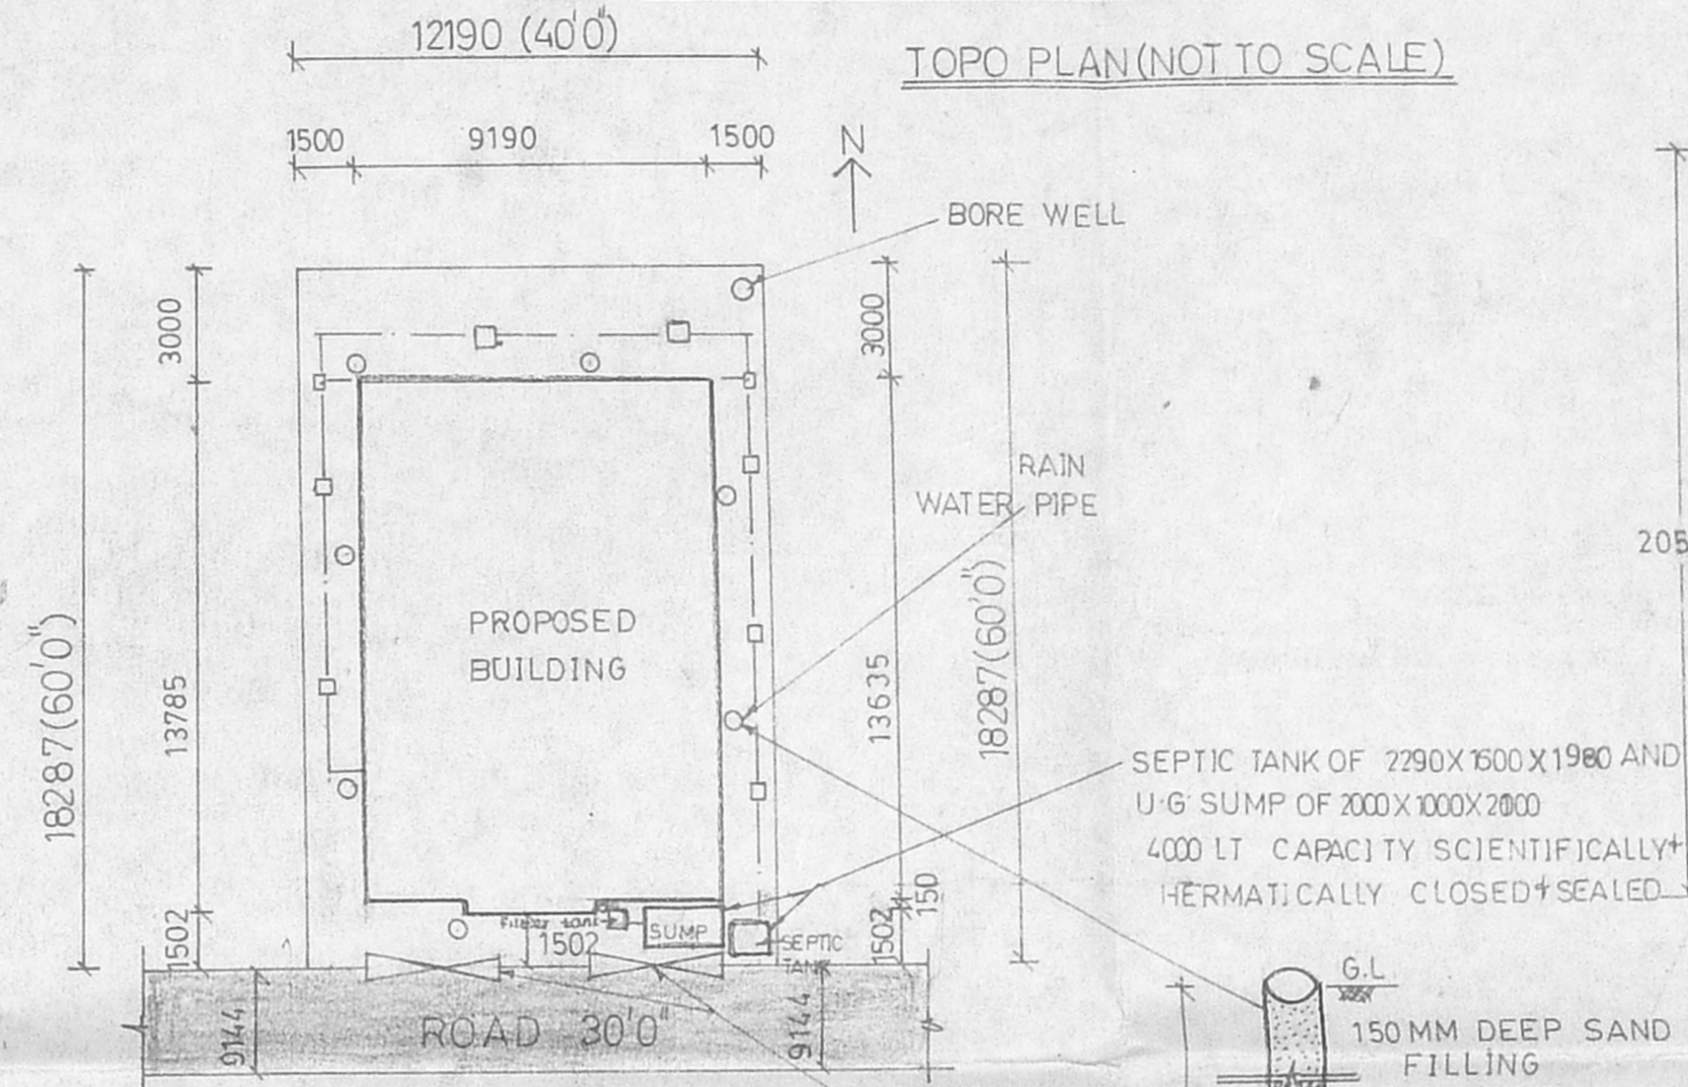

SITE PLAN (SCALE 1:200)

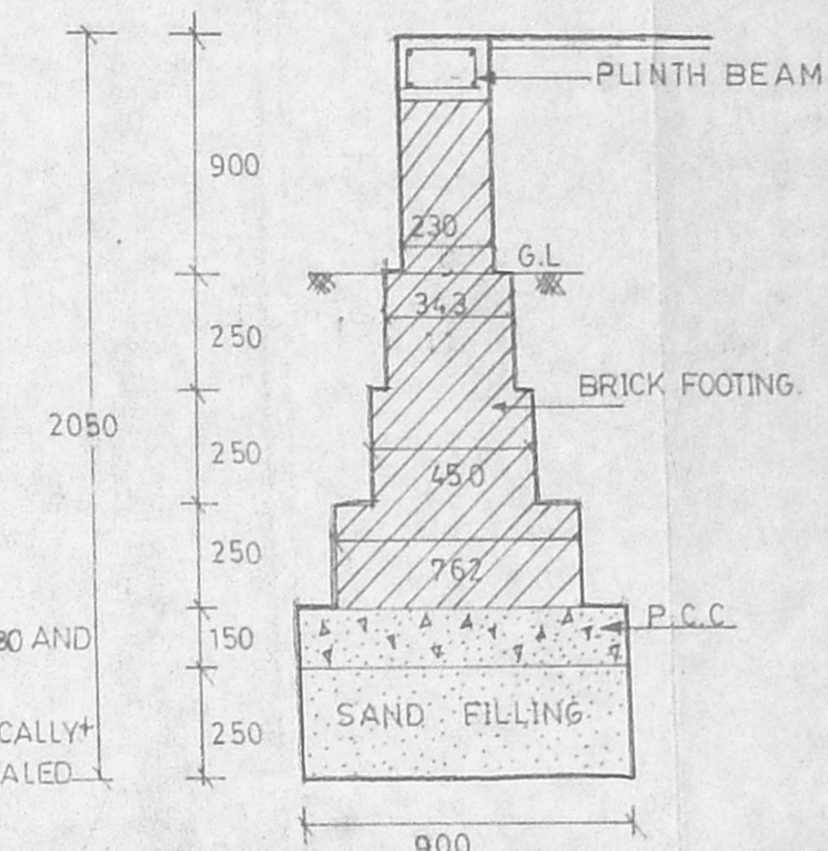

FOUNDATION DETAIL

- SPECIFICATION**
1. FOUNDATION AND LEVELLING COURSE IN P.C.C 1:4:8
 2. BRICK MASONRY FOR 1:5 MIX.
 3. BRICK WORK IN C.M. 1:5 MIX.
 4. COLUMNS AND SLABS OF REINFORCED CEMENT CONCRETE 1:2:4 MIX.
 5. CEMENT PLASTERING IN C.M. 1:5 MIX.
 6. FLOORING WITH MOSAIC
 7. WEATHERING COURSE WITH A LAYER OF FLAT LAID IN C.M. 1:4 MIX.
 8. DOORS ARE MADE OF WELL SEASONED WOOD
 9. GRILLS MADE OF STEEL ALL COATED WITH ENAMEL PAINT 2 COATS.

- BOUNDARY
- PROPOSED
- ROAD
- SEWER LINE.


- JOINERY DETAIL**
1. MD COUNTRYWOOD MAIN DOOR 1050 X 2100
 2. D " WOOD DOOR 900 X 2100
 3. D1 " " 750 X 2100
 4. W " WOOD WINDOW 2000 X 1350
 5. W1 " " 1000 X 1350
 6. W2 " " 1050 X 1350
 7. W3 BAY " 2000 X 1350
 8. KW C.W. KITCHEN WINDOW 1000 X 1200
 9. V. C.W. VENTILATOR 600 X 750
 10. W4 C.W. WINDOW 750 X 2000
 11. BW BOW WINDOW 2100 X 1350

AREA STATEMENT


	SGM	SGM
PLOT AREA	2400 SFT	222.965 ≈ 223.00
HOUSE NO.1		55.700
HOUSE NO.2		58.150
HOUSE NO.3		65.870
HOUSE NO.4		54.622
GROUND FLOOR		125.808
FIRST FLOOR		142.458
TOTAL		268.266 ≈ 269 SGM

F.S.1 269/1206
223


PLOT COVERAGE: $\frac{14.3 \times 100}{223} = 64\%$
223

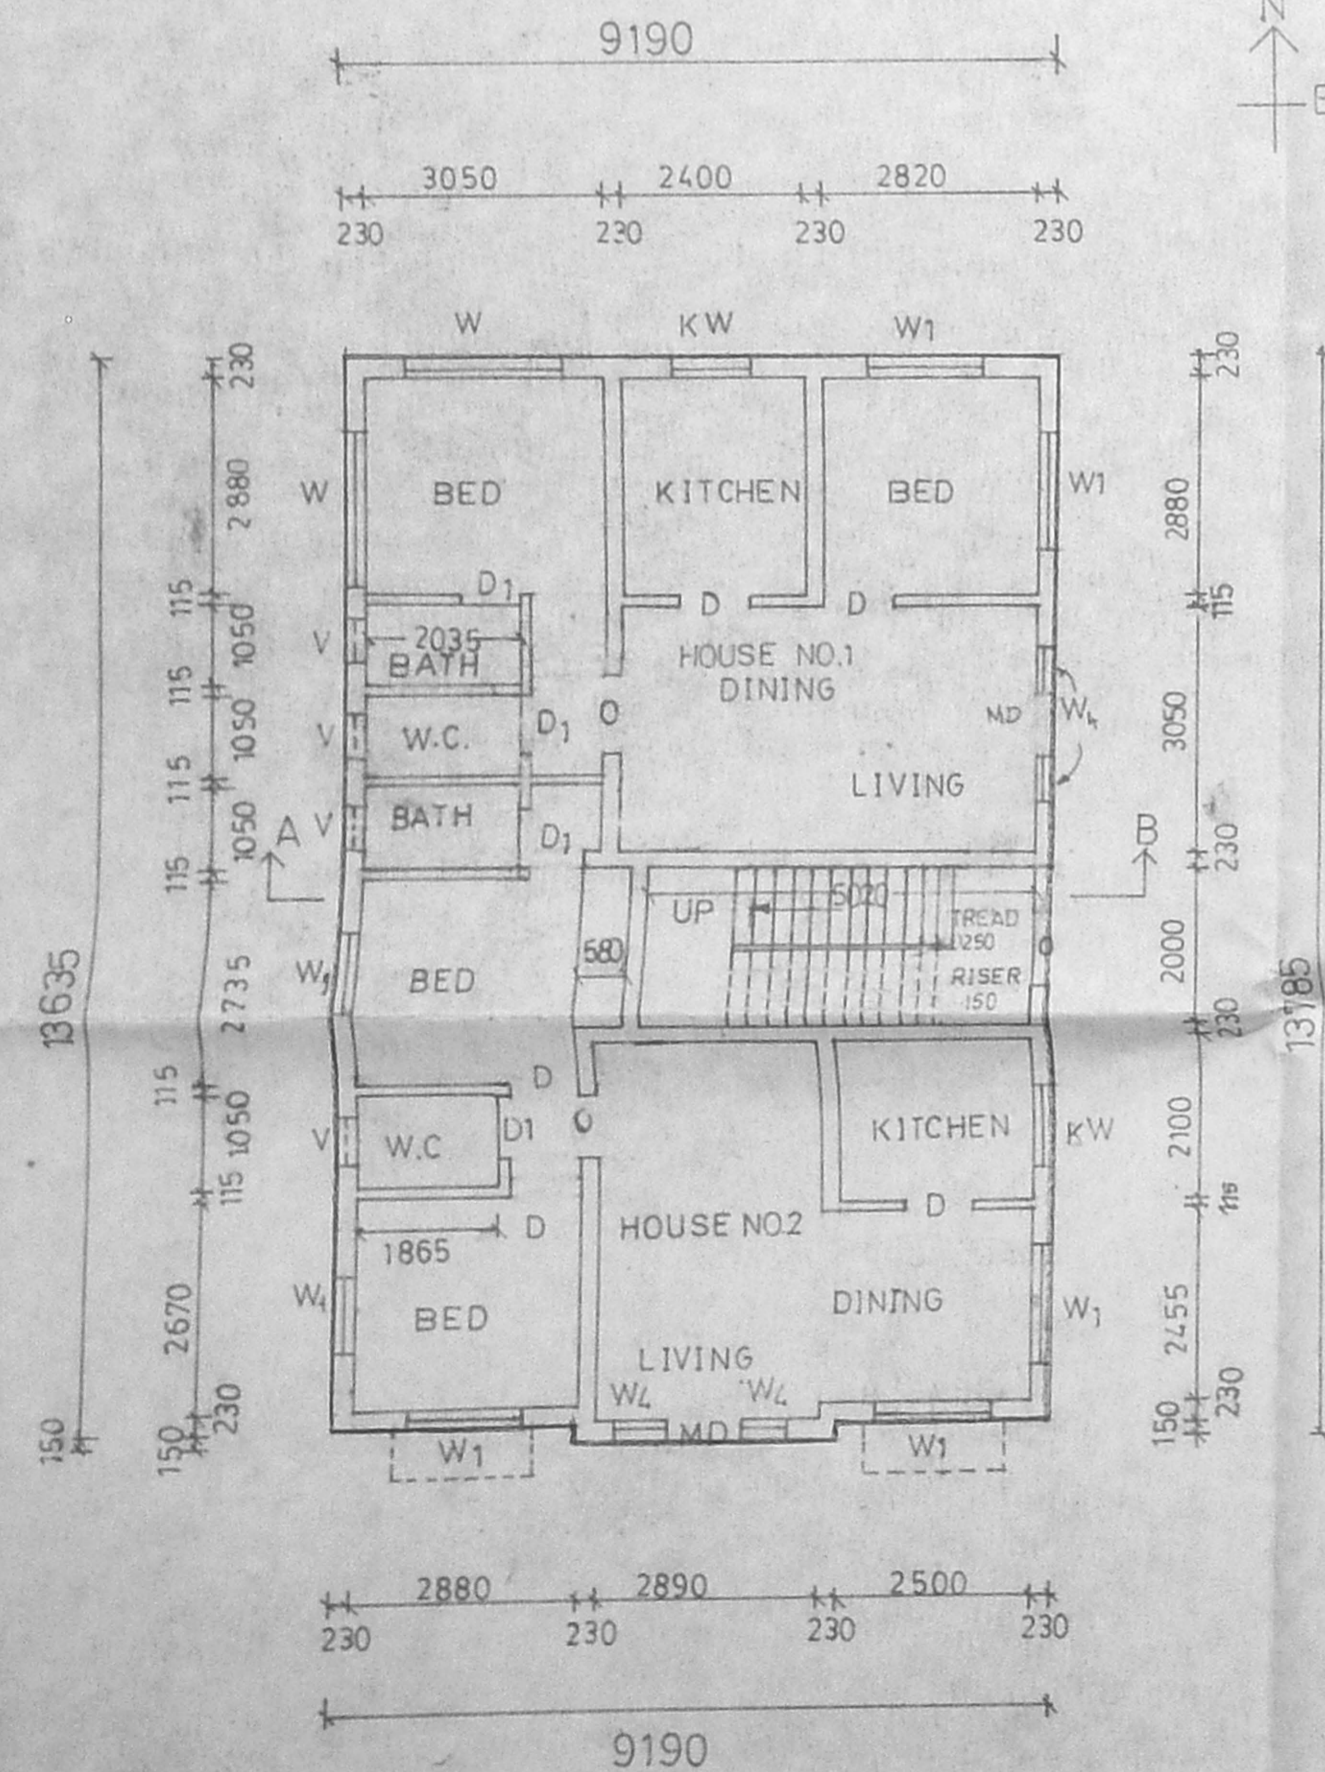


GROUND FLOOR PLAN

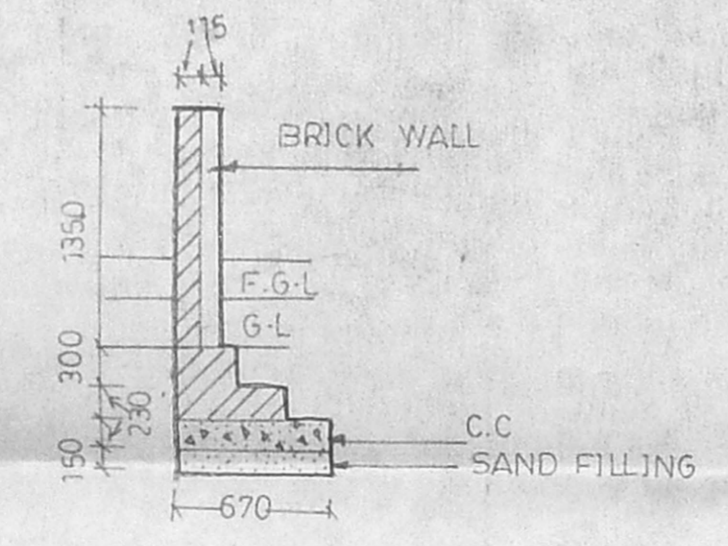



COMPOUND WALL

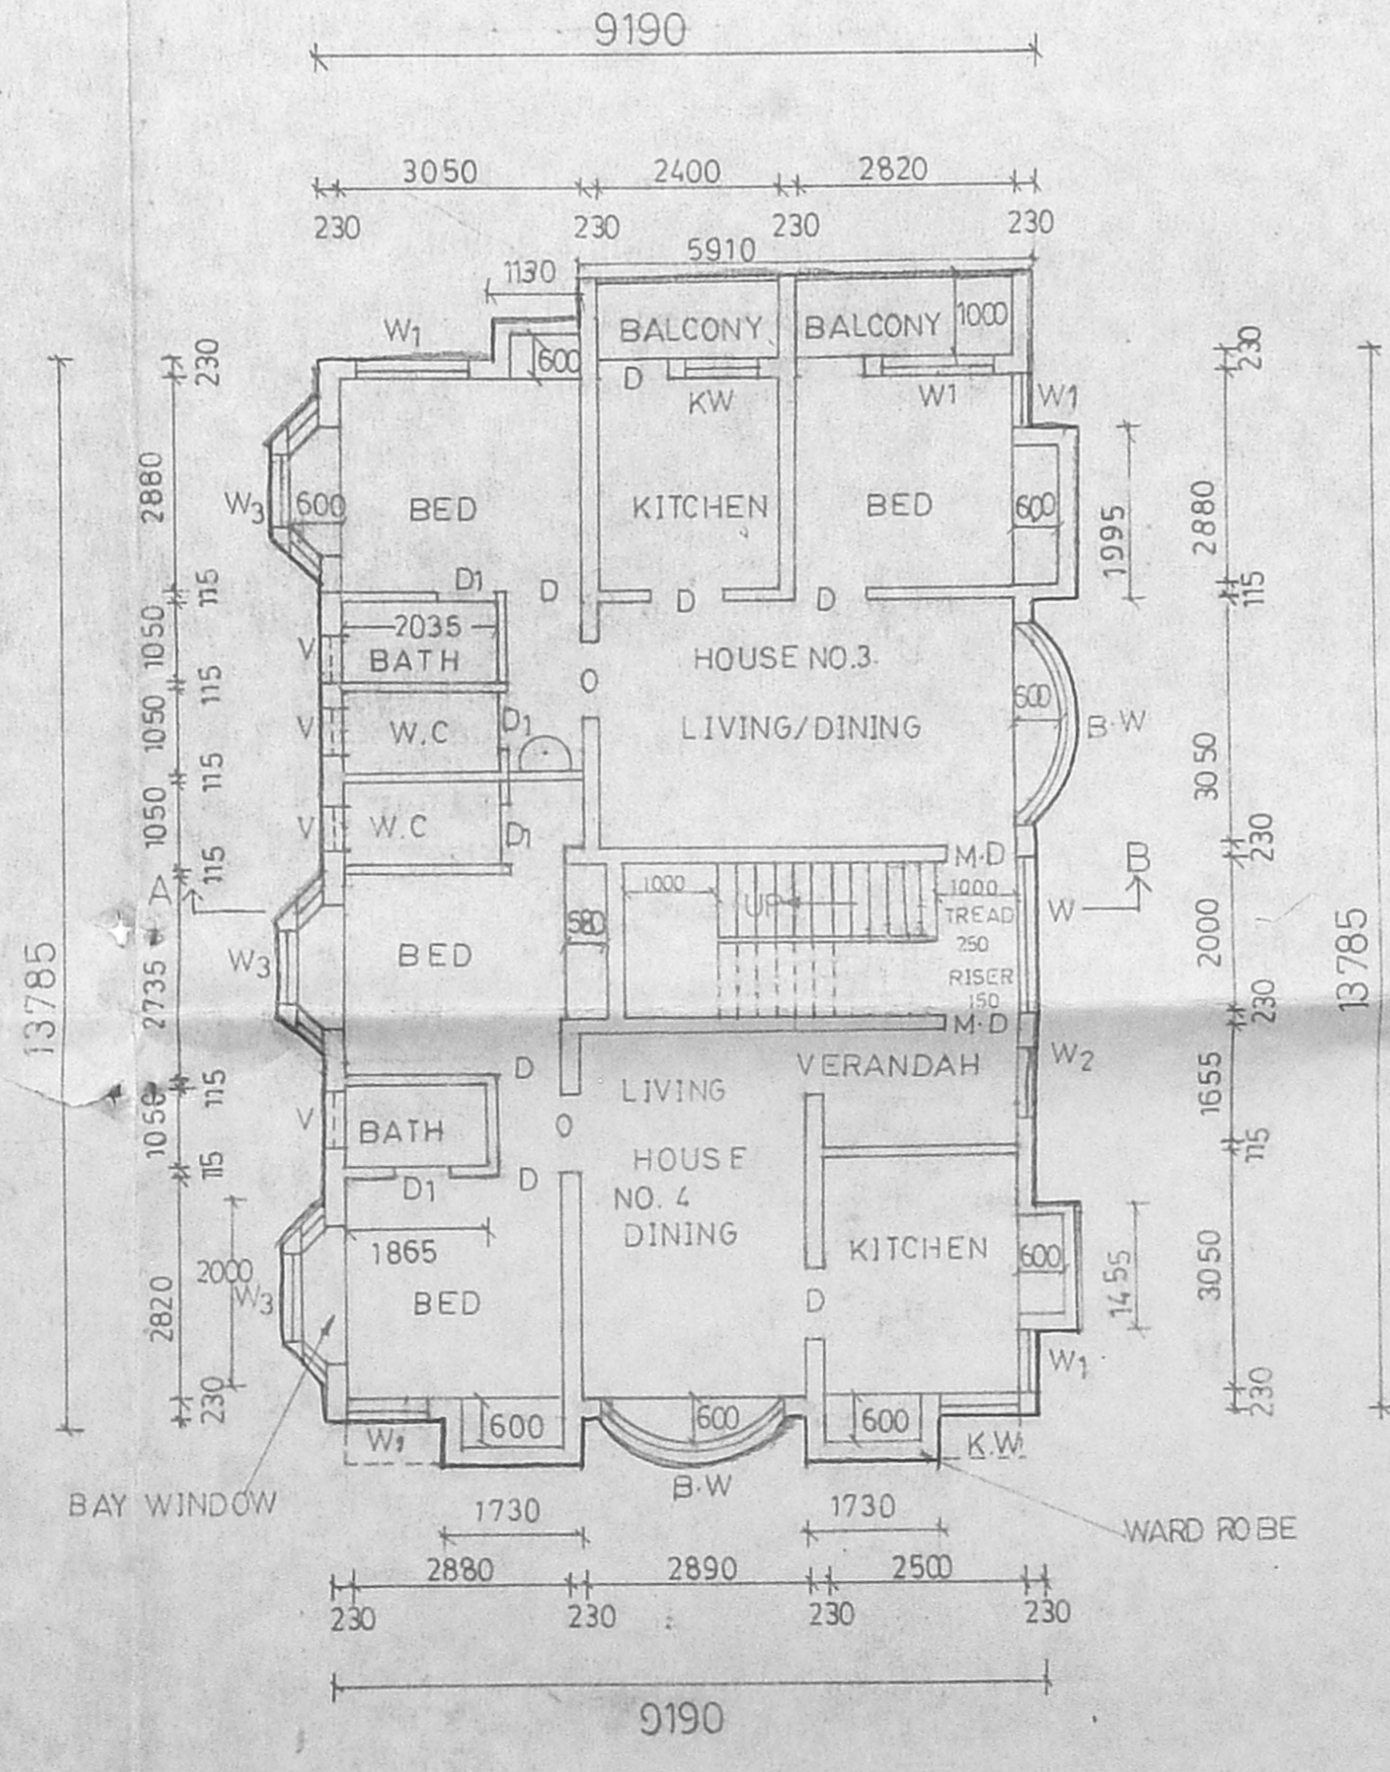

FIRST FLOOR PLAN

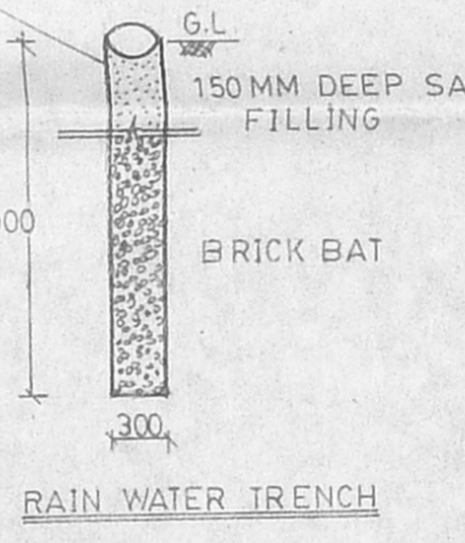

RAIN WATER TRENCH

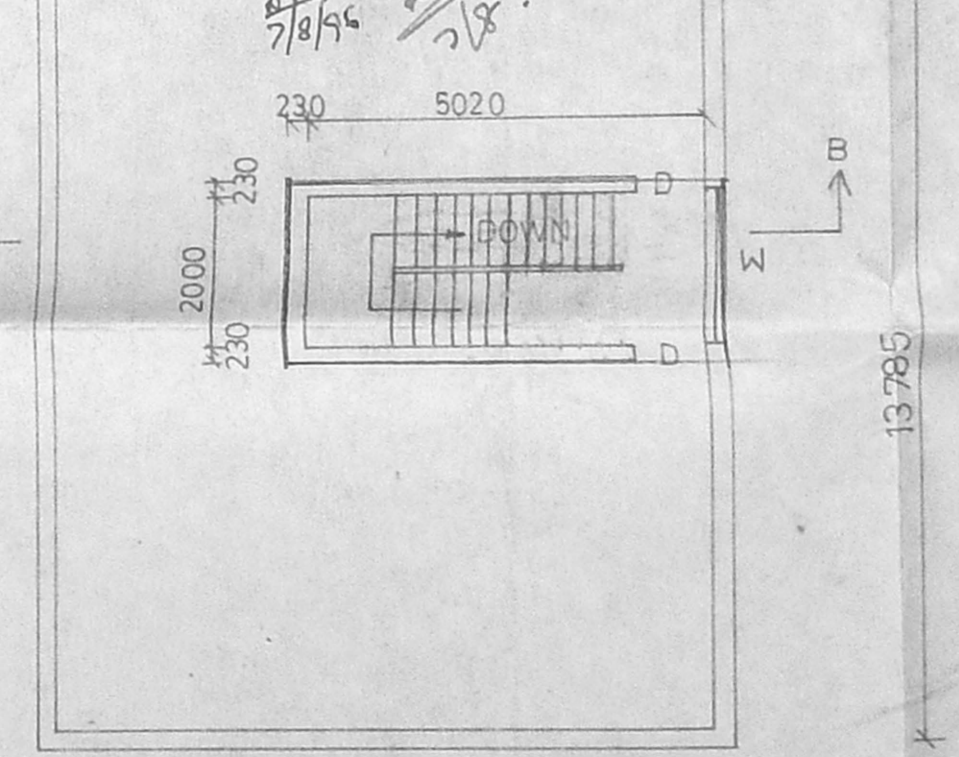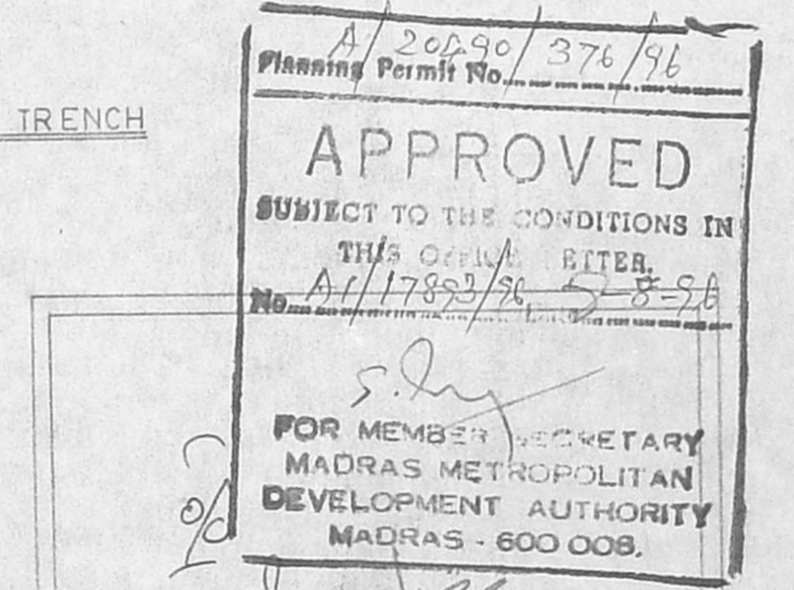

TERRACE FLOOR PLAN

PROPOSED APARTMENT AT
PLOT NO. 362, ASHTALAKSHMI NAGAR,
MADURAVOYAL MATHURA ALAPAKKAM VILLAGE,
SAIDAPET TALUK,
CHENGAI MGR DISTRICT,
RS NO. 327/2 A AND 327/2 B.

ARCHITECT
S. K. ANURADHA M. ARCH; MCA;
NO. 5, 3RD NORTON ROAD, MANDAVELI PAKKAM,
MADRAS 600 028, PHONE 4935645, 4938685.

S. P. Krishnamoorthy
B.E., F.I.E., C. Eng., F.I.V.
Licensed Surveyor Class I No. 202
Corporation of Madras
E-2, Adyar Apartments
Kotturum Madras 600 085
S. P. Krishnamoorthy
LICENSED SURVEYOR

DATE: 3.5.96	PLAN, SECTION, ELEVATION.
SCALE: 1:100	DIMENSIONS ARE IN MILLIMETER.
CORP.	JOB NO. B-122 DRAWN.DS DWG. NO.1